

SITE PLAN
SCALE: 1/4" = 1'-0"

GENERAL DESCRIPTION
 PROPERTY: 2.19 ACRES
 LOT 11, 12, 13
 ST. JAMES STREET
 ST. MATTHEW AVE
 PLAN 9429

METRO COPY

DEPT.	APPLIED FOR		APPROVED	
	DATE	TIME	DATE	TIME
ENGINEERING	1/14/39	11:00 AM	1/14/39	11:00 AM
PLANNING	1/14/39	11:00 AM	1/14/39	11:00 AM
ST. JAMES				
ST. MATTHEW				
ST. JAMES				
ST. MATTHEW				
ST. JAMES				
ST. MATTHEW				

TYPE D - 3.2.1.39.
 2 stories - 1 story
 Area = 17,000 sq

6040
 68

ST. JAMES INDUSTRIAL PARK
 BUILDING N° 2





DATE: 1/17/39

BY: D.A.K.




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0-1 FINISHING
 0-2 FRAME CANT
 ELEV. 122'-0" 1/2
 TOP OF METAL ANGLE

1-Bay Assembly
 1-ND. Flat Roofs (2nd) Raising

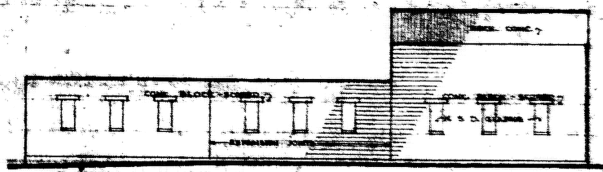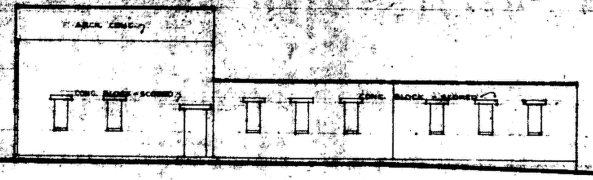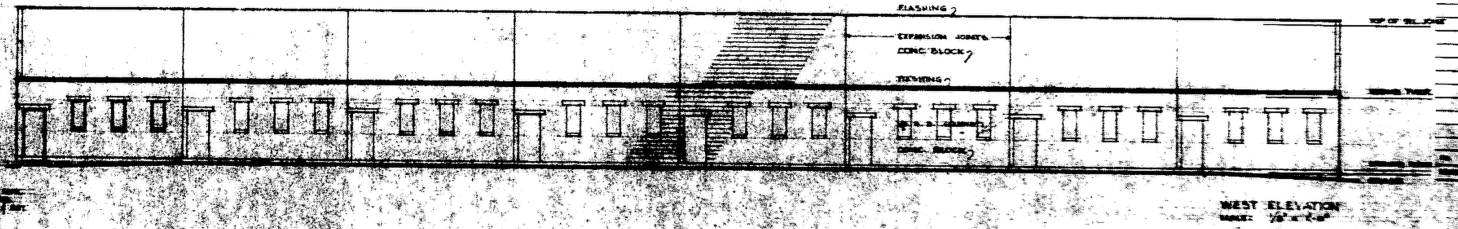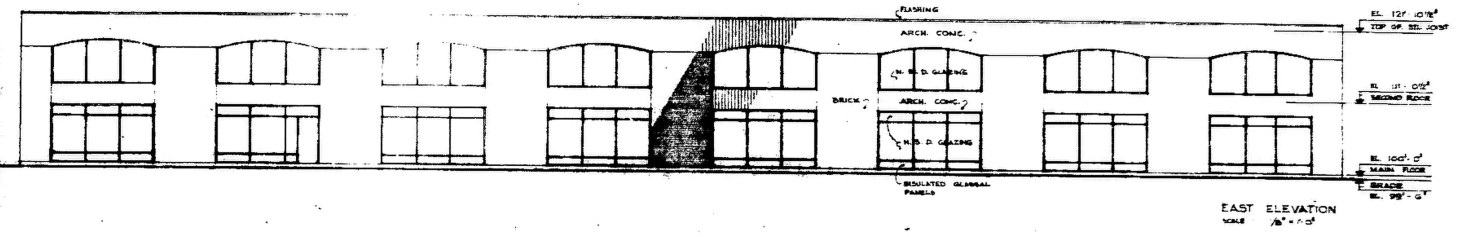


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ST. JAMES INDUSTRIAL PARK LTD.
 BUILDING - 12-A-2

W.A. BRIDGEMAN & ASSOCIATES ARCHITECTS
 1000 BROADWAY, NEW YORK 17, N.Y.

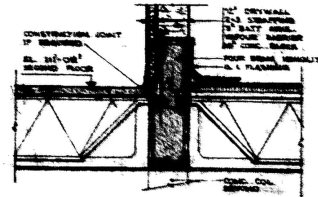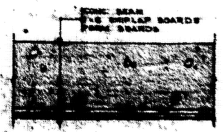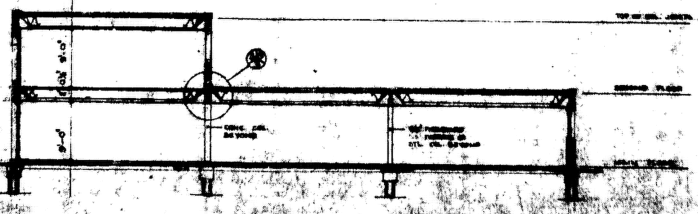DATE: 12-15-58
 SHEET NO. 073




GENERAL NOTES:

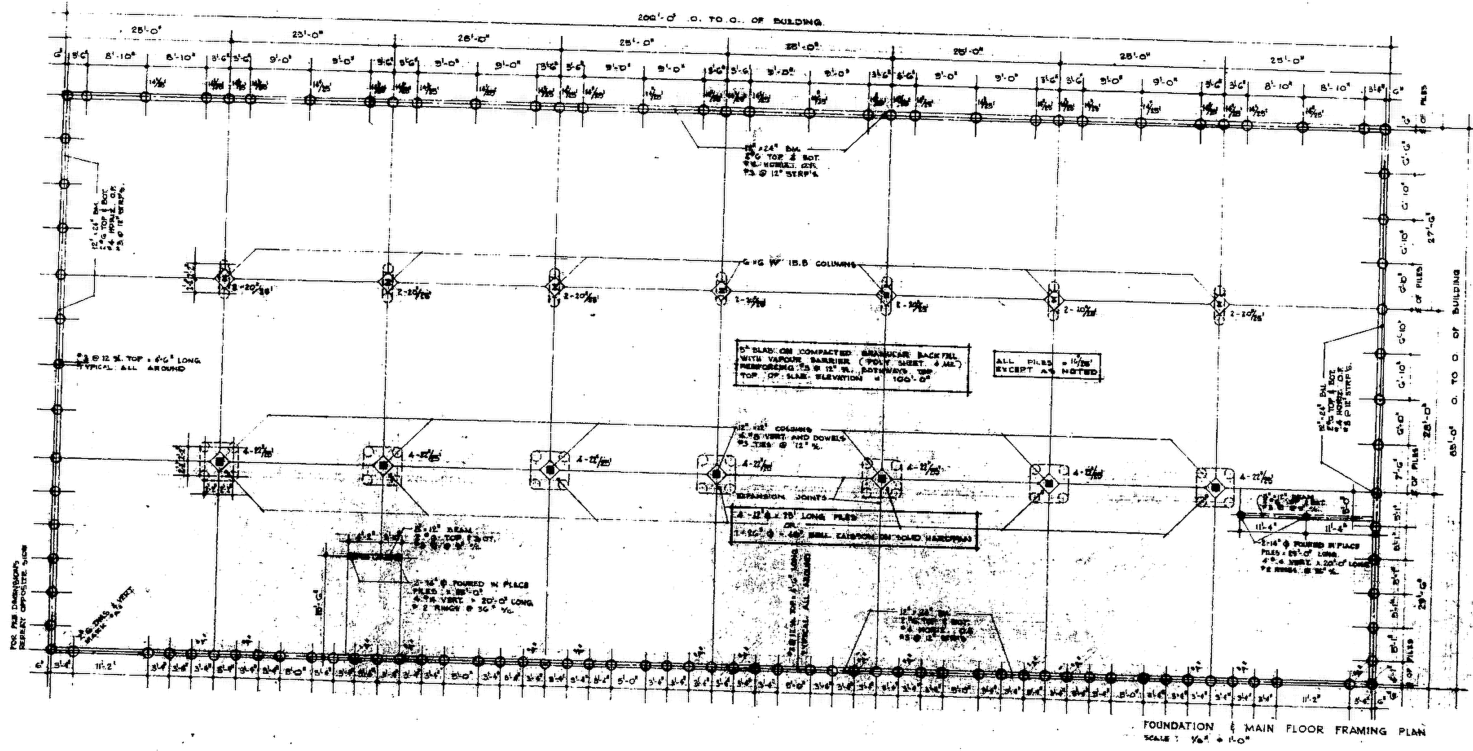
CONC. STRENGTH @ 28 DAYS.
 FURF: 1500 P.S.I. (QUINCY PORTLAND CEMENT SLAB ON PILE) 2500 P.S.I.
 BEAM: 3000 P.S.I.

ALL REINFORCING STEEL TO BE INTERMEDIATE DETAILS ACCORDING TO LATEST A.C.I. GRADE DEFORMED BARS. NEW BUILT STEEL STANDARD.


FRAME ALL OPENED WITH 2\"/>

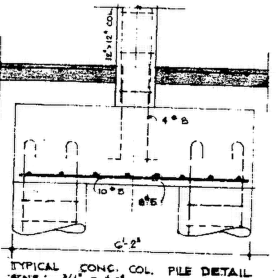


TYPICAL CONC. COL. PILE DETAIL
 SCALE: 3/4" = 1'-0"

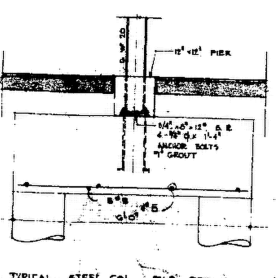

TYPICAL STEEL COL. PILE DETAIL
 SCALE: 3/4" = 1'-0"

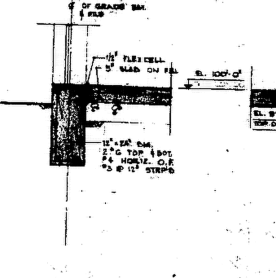


TYPICAL GRADE BEAM DETAIL
 SCALE: 3/4" = 1'-0"

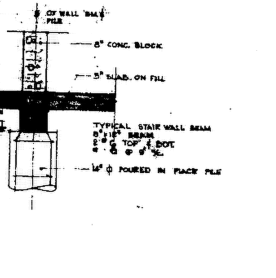

TYPICAL STAIR BEAM PILE DETAIL
 SCALE: 3/4" = 1'-0"

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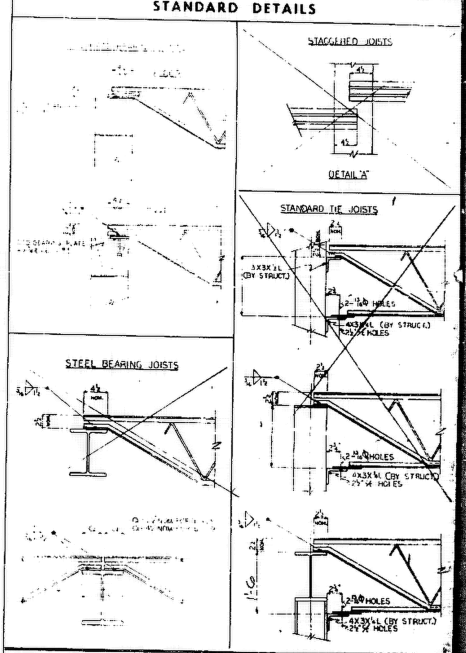
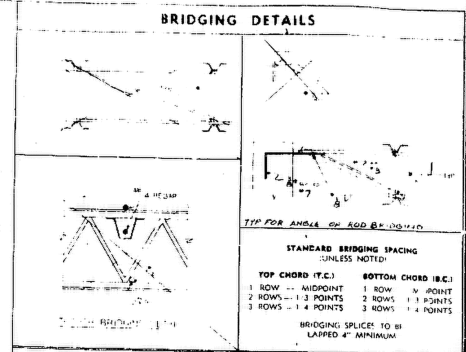
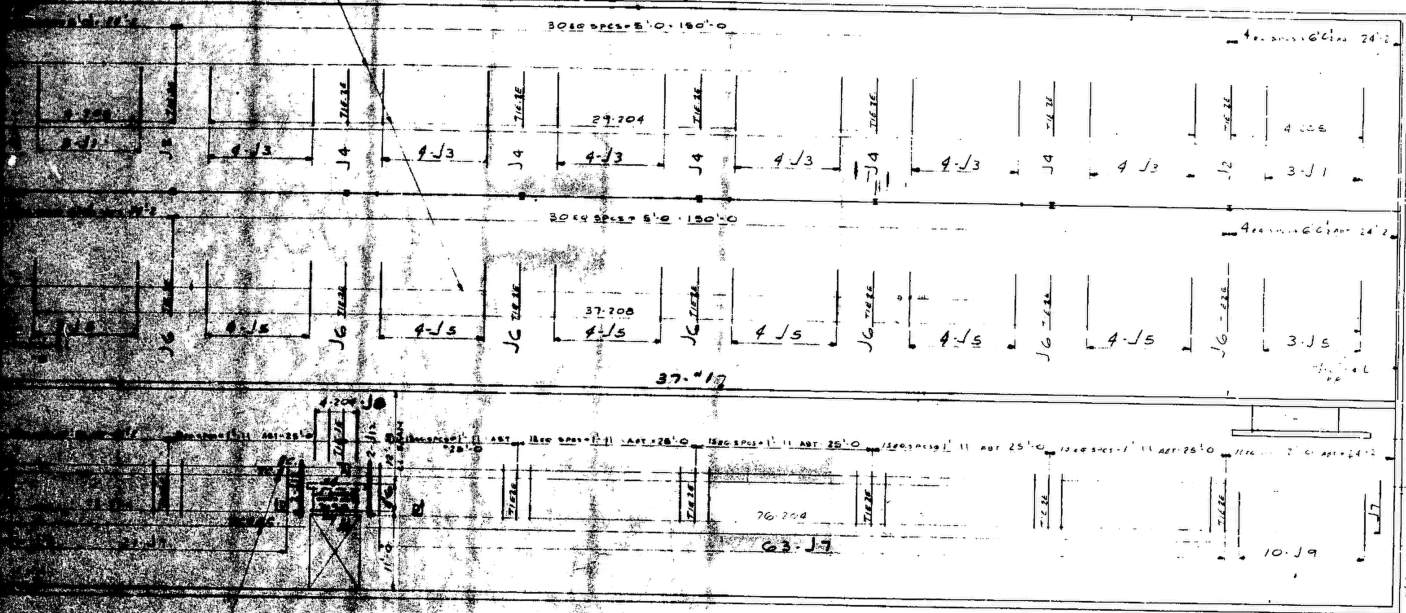
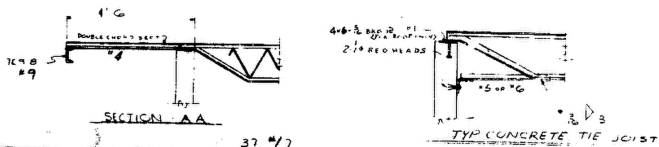
PRINTED DATE: [REDACTED]

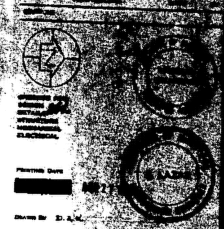DRAWN BY: D. A. M.

UNIVERSITY OF ILLINOIS ARCHITECTURE

ST. JAMES INDUSTRIAL PARK BUILDING N. 2

FOUNDATION & MAIN FLOOR FRAMING & DETAILS
 SHEET NO. GF.31 A-51



ERECTION -- BY DOMINION BRIDGE CO. BY OTHERS
 SHOP PAINT -- 1 COAT STANDARD PRIMER -- SW 6016G38 (HP-40)

V-FIB FORMS 2" GAUGE	YES	NO	(1)
TRUSS BRIDGING	YES	NO	(1)
PENCIL RODS 1/4 DIA AT 12" EW	YES	NO	(1)
WELDED WIRE MESH	YES	NO	(1)
STEEL DECK GAUGE	YES	NO	(1)

CEILING EXTENSIONS AS REQUIRED
 LOCATION OF JOIST MARKS ON DIAGRAM CORRESPOND TO MARKS ON JOISTS

OPEN WEB JOIST SETTING DIAGRAM

STRUCTURE	ST. JAMES INDUSTRIAL PK. BLDG # 2	CONTRACT	H1634
PURCHASER	ST. JAMES INDUSTRIAL PK	RELATED CONTRACT	W4808
DRAWN BY	B. SMITH	CHECKED	JOIST SQUAD
DATE	7-10-68	DATE	LYONS

DOMINION BRIDGE COMPANY LTD.

6040
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PROVINCE OF MARYLAND
REGISTERED ENGINEER
OAKES

